North Hampton Safety Building

North Hampton, NH



Revision Schedule

Progress Print 12/13/21

MASTER ABBREVIATION KEY:

DWG DRAWING

AC AIR CONDITIONER E EAST

ACI	AMERICAN CONCRETE	EJ	EXPANSION JOINT			SC	SOLID CORE
	INSTITUTE	EJC	EXPANSION JOINT COVER	MAS	MASONRY	SCED	SCHEDULE
ACOUST	ACOUSTIC	EL	ELEVATION	MAT	MATERIAL	SD	STORM DRAIN
AFF	ABOVE FINISH FLOOR	ELEC	ELECTRICAL	MAX	MAXIMUM	SF	SQUARE FOOT
ALT	ALTERNATE	ELEV	ELEVATOR	MECH	MECHANICAL	SH	SHOWER
ALUM	ALUMINUM	EQ	EQUAL	MEM	MEMBRANE	SHT	SHEET
ANCH	ANCHOR	EQUIP	EQUIPMENT	MEP	MECHANICAL,	SIM	SIMILAR
ANOD	ANODIZED	ER	EMERGENCY ROOM		ELECTRICAL, PLUMBING	SL	SLIDING
ASTM	AMERICAN SOCIETY FOR	EST	ESTIMATE	METTP	METAL TOILET PARTITION	SMR	SINGLE PLY MEMBRANE
	TESTING MATERIALS	EWC	ELECTRICAL WATER	MFR	MANUFACTURER		ROOF
			COOLER	MH	MANHOLE	SP/PT/FIN	SPECIAL PAINT FINISH
BD	BOARD	EXH	EXHAUST	MIN	MINIMUM	SPEC	SPECIFICATION
BIT	BITUMINOUS	EXIST	EXISTING	MISC	MISCELLANEOUS	SPKR	SPEAKER
BL	BUILDING LINE	EXP	EXPANSION	MO	MASONRY OPENING	5Q	SQUARE
BLDG	BUILDING	EXPD	EXPANDED	MTL	METAL	55	STAINLESS STEEL
BLK	BLOCK	EXT	EXTERIOR	MULL	MULLION	STA	STATION
BLKG	BLOCKING					STD	STANDARD
ВМ	BEAM	F/F	FACE OF FOUNDATION	N	NORTH	STL	STEEL
BOC	BOTTOM OF CURB		WALL	NAT	NATURAL	STOR	STORAGE
BOF	BOTTOM OF FOOTING	FA	FRESH AIR	NEC	NECESSARY	STRG	STRINGER
	ELEVATION	FAP	FIRE ALARM PANEL	NIC	NOT IN CONTRACT	STRUCT	STRUCTURAL
BOT	BOTTOM	FD	FLOOR DRAIN	NOM	NOMINAL	SU	SITE UTILITY
BRG	BEARING	FE	FIRE EXTINGUISHER	NRC	NOISE REDUCTION	SUSP	SUSPEND (SUSPENDED)
BRK	BRICK	FEC	FIRE EXTINGUISHER		COEFFICIENT	SYMM	SYMMETRICAL
BSMT	BASEMENT		CABINET	NTS	NOT TO SCALE	SYS	SYSTEM
BTW	BETWEEN	FIN	FINISH				
BUR	BUILT-UP ROOF	FL	FLOW LINE	OC	ON CENTER	Τ	TREAD
		FLR	FLOOR	OD	OUTSIDE DIAMETER	T#G	TONGUE & GROOVED
CAB	CABINET	FND	FOUNDATION	OF/C	OUTSIDE FACE OF	T/FRM	TOP OF FRAME
СВ	CATCH BASIN	FOF	FACE OF FINISH		CONCRETE	T/SLB	TOP OF SLAB
CER	CERAMIC	FOM	FACE OF MASONRY	OH	OVERHEAD	TB	TACKBOARD
CF	CUBIC FOOT	FOS	FACE OF STUD	OPG	OPENING	TEL	TELEPHONE
Cl	CAST IRON	FR	FIRE RATED	OPP	OPPOSITE	TEMP	TEMPORARY
CJ	CONTROL JOINT	FS	FULL SIZE	OR	OPERATING ROOM	TERR	TERRAZZO
CL	CLOSET	FT	FOOT			THK	THICK
CLCB	CURBLESS CATCH BASIN	FTG	FOOTING	PBD	PARTICLE BOARD	THLD	THRESHOLD
CLG	CEILING	FUR	FURRED (FURRING)	PCF	POUNDS PER CUBIC	TOC	TOP OF CURB
CM	CONTRACT MANAGER	FVC	FIRE VALVE CABINET		FOOT	TOF	TOP OF FOUNDATION
CMU	CONCRETE MASONRY			PL	PROPERTY LINE	TOS	TOP OF SLAB
	UNIT	GA	GAUGE	PLAM	PLASTIC LAMINATE	TOW	TOP OF WALL ELEVATIO
CO	CLEAN OUT	GALV	GALVANIZED	PLAS	PLASTER	TR	TO REMAIN
COL	COLUMN	GC	GENERAL CONTRACTOR	PLYWD	PLYWOOD	TYP	TYPICAL
COMP	COMPACTED	GEN	GENERAL	PNL	PANEL		
CONC	(COMPOSITION)	GL	GLASS	PSF	POUNDS PER SQUARE	UH	UNIT HEATER
CONC CONST	CONCRETE CONSTRUCTION	GLZ	GLAZING	PSI	FOOT POUNDS PER SQUARE	UL	UNDERWRITERS
CONT	CONTINUOUS	GRD	GRADE	1 01	INCH		LABORATORIES, INC.
		GYP	GYPSUM	PT	PAINT	UOD	UNDERSIDE OF DECK
CORR	CONTRACTOR			PTD	PAINTED	UON	UNLESS OTHERWISE
CORR	CONTROL BANEL	HŧV	HEATING & VENTILATING	PTN	PARTITION		NOTED
CP	CONTROL PANEL	HC	HANDICAP	PVC	POLYVINYL CHLORIDE	UR	URINAL
CSG CSMT	CASING	HDWD	HARDWOOD	1 00	TOLIVINIE CHLORIDE	UV	UNIT VENTILATOR
CSMT CT	CASEMENT CERAMIC TILE	HGT	HEIGHT	QT	QUARRY TILE		
		НМ	HOLLOW METAL	αı	QUITALE	VAR	VARIES OR VARIABLE
CTR	CURIC YARD	HP	HIGH POINT	R	RADIUS	VB	VINYL BASE
CY	CUBIC YARD	HVAC	HEATING, VENTILATION,	R/A	RETURN AIR	VCT	VINYL COMPOSITION TI
DE	DRINKING FOUNTAIN		AIR CONDITIONING	RC	REINFORCED CONCRETE	VERT	VERTICAL
DF	DRINKING FOUNTAIN	HWH	HOT WATER HEATER	RD	ROOF DRAIN	VEST	VESTIBULE
DIAC	DIAMETER			REF	REFERENCE	VIF	VERIFY IN FIELD
DIAG	DIAGONAL	ID	INSIDE DIAMETER	REFR	REFRIGERATOR	VNR	VENEER
DIM	DIMENSION	IN	INCH	REINF	REINFORCE	VOL	VOLUME
DL	DEAD LOAD	INSUL	INSULATION	REQD	REQUIRED		
DN	DOWN	INT	INTERIOR	RGH	ROUGH	W	WEST
DR	DOOR	INV	INVERT	RL	RAIN LEADER	W/	WITH
DS DS/C	DOWNSPOUT DRIVE SIDE OF CURB			RM	ROOM	WC	WATER CLOSET
17.フル・	DEIVE SIDE OF CHEE	10	INNITADIC ALACET	IZIVI	NOOIVI	11.00	WOOD

LOCUS MAP: (N.T.S.)

S-TRAP SEDIMENT TRAP

WD WOOD

WDW WINDOW

WGL WIRE GLASS

WEATHERPROOF


WWF WELDED WIRE FABRIC


(WATERPROOFING)

RO ROUGH OPENING

ROW RIGHT OF WAY

RQMT REQUIREMENT

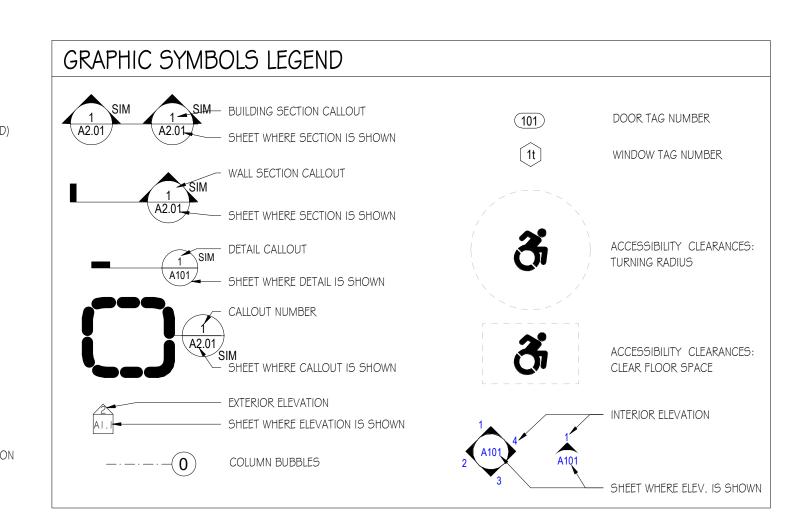

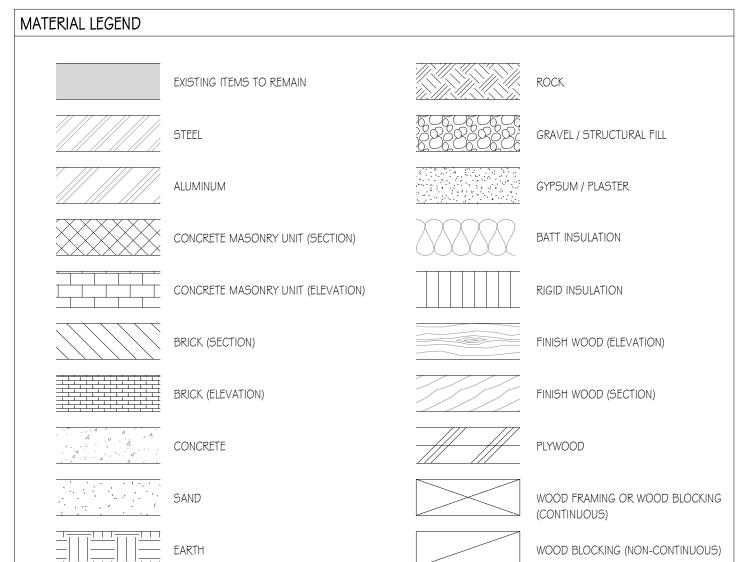

DRAWING SHEET INDEX:

Sheet	Sheet Name	Issued	Revision	Revision Date
A1	First Floor Plan	12/13/21		
A2	Second Floor Plan	12/13/21		
A3	Exterior Elevations	12/13/21		
A4	Exterior Color Renderings	12/13/21		

Architect of Record:

T | W Designs, LLC 254 Drake Hill Rd. Strafford, NH 03884 603-664-2181

Civil Engineer:

Structural Engineer:

Electrical Engineer:

Mechanical Engineer:

Fire Protection Eng.:

General Contractor:

Ricci Construction Portsmouth, NH

Project Info:

GENERAL NOTES:

- DO NOT SCALE DRAWING OR DIMENSIONS. FOR MISSING DIMENSIONS OR DIMENSIONS IN CONFLICT, CONTACT THE CONTRACTOR IMMEDIATELY BEFORE CONTINUING WITH WORK. ANY DISCREPANCIES IN THESE PLANS WILL BE BROUGHT TO THE CONTRACTOR'S ATTENTION IN WRITING IMMEDIATELY
- REFER TO MECHANICAL, ELECTRICAL, PLUMBING, AND FIRE PROTECTION DESIGN-BUILD PLANS AND SPECIFICATION FOR LOCATIONS OF ALL BLOCK OUTS, INSERTS, OPENINGS, CURBS, BASES, & PADS THAT ARE NOT DIMENSIONED OR SHOWN ON CONTRACTOR'S DWG'S. OR STRUCTURAL DWG'S.
- STRUCTURAL STEEL, MECHANICAL, ELECTRICAL, PLUMBING, AND FIRE PROTECTION PLANS AND SPECIFICATION SHALL BE PROVIDED AND ARE THE RESPONSIBILITY OF THERE RESPECTIVE SUBCONTRACTORS IF NOT CARRIED IN ARCHITECTURAL SERVICES
- ALL CONSTRUCTION SHALL CONFORM TO AND BE IN ACCORDANCE WITH THE REGULATOR REQUIREMENTS MANDATED BY ALL FEDERAL, STATE AND LOCAL AUTHORITIES HAVING JURISDICTION IN ACCORDANCE TO THE STATE IN WHICH THE WORK IS PERFORMED (STATE BUILDING CODE, STATE LIFE SAFETY & FIRE CODE ETC.)
- THE CONTRACTOR SHALL REVIEW ALL DOCUMENTS AND VERIFY ALL DIMENSIONS AND FIELD CONDITIONS, AND SHALL CONFIRM WORK IS BUILDABLE AS SHOWN. ANY CONFLICTS OR OMISSIONS, ETC. SHALL BE
- IMMEDIATELY REPORTED IN WRITING TO THE ARCHITECT FOR CLARIFICATION


- DIMENSIONS ARE FROM EXTERIOR FACE OF FOUNDATION, VENEER, OR WALL STUD AND TO CENTER OF ALL INTERIOR STUD WALLS OR FACE OF INTERIOR MASONRY. UNLESS NOTED OTHERWISE. CLEAR DIMENSIONS ARE FROM FACE TO FACE OF WALL FINISH. UNLESS NOTED OTHERWISE
- REFER TO MECHANICAL DRAWINGS / SPEC. FOR ALL SIZES AND LOCATIONS OF MECHANICAL DUCT WORK
- UNLESS OBVIOUSLY SHOWN OTHERWISE, DOOR LOCATIONS NOT DESIGNATED BY WRITTEN DIMENSION SHALL BE CENTERED IN THE WALL OR SHALL BE LOCATED FOUR (4) INCHES FROM FINISH WALL TO EDGE OF DOOR
- PENETRATIONS OF ALL FIRE RATED ASSEMBLIES SHALL BE PROTECTED BY LIKE RATED CONSTRUCTION DAMPERS, SEALANTS, COLLARS, ETC., TYPICAL. CONTRACTOR SHALL FURNISH, LOCATE AND INSTALL ALL ACCESS PANELS AS REQUIRED AFTER INSTALLATION OF MECHANICAL DUCTS, PLUMBING AND ELECTRICAL WORK, FIRE RATED AS REQUIRED.
- FURNISH AND INSTALL SOLID BLOCKING BEHIND ALL WALL HUNG MILLWORK ITEMS, RAILS, FIXTURES, GRAB BARS, ETC. . WHERE INDICATED OR REQUIRED.
- CONTRACTOR SHALL LAYOUT OR MARK, ALL EQUIPMENT, SYSTEMS AND MILLWORK ON THE FLOOR FOR ARCHITECT OR OWNER'S APPROVAL PRIOR TO BEGINNING CEILING / OVER HEAD WORK. ALL SPRINKLER HEAD LOCATIONS, MAINS, BRANCHES AND RISER PIPE LOCATIONS MUST BE COORDINATED WITH THE DESIGN / BUILD CONTRACTOR PRIOR TO WORK.

FURNISH AND INSTALL FIRE EXTINGUISHERS IN TYPE, QUANTITY, AND LOCATION PER LOCAL FIRE DEPARTMENT. TYPICAL

- CONTRACTOR SHALL VERIFY, COORDINATE LOCATION WITH THE ARCHITECT ANY SMOKE, CARBON MONOXIDE DETECTOR OR FIRE ALARM DEVICE AS REQUIRED BY THE LOCAL FIRE DEPARTMENT. FURNISH & INSTALL FIRE DAMPERS WITH FUSIBLE LOUVER WHEREVER DUCT WORK PENETRATES ONE OR TWO HOUR CEILINGS OR WALLS. TYPICAL UNLESS NOTED OTHERWISE.
- 20. PROVIDE PLASTER AND GYPSUM WALL BOARD CONTROL JOINTS AT 30'-0" ON CENTER FROM FLOOR TO CEILING, OR AS NOTED ON THE CONSTRUCTION DOCUMENTS. VERIFY IN FEILD WITH ARCHITECT PRIOR TO WORLD

21018 **Project Cover** Sheet

SHEET NUMBER

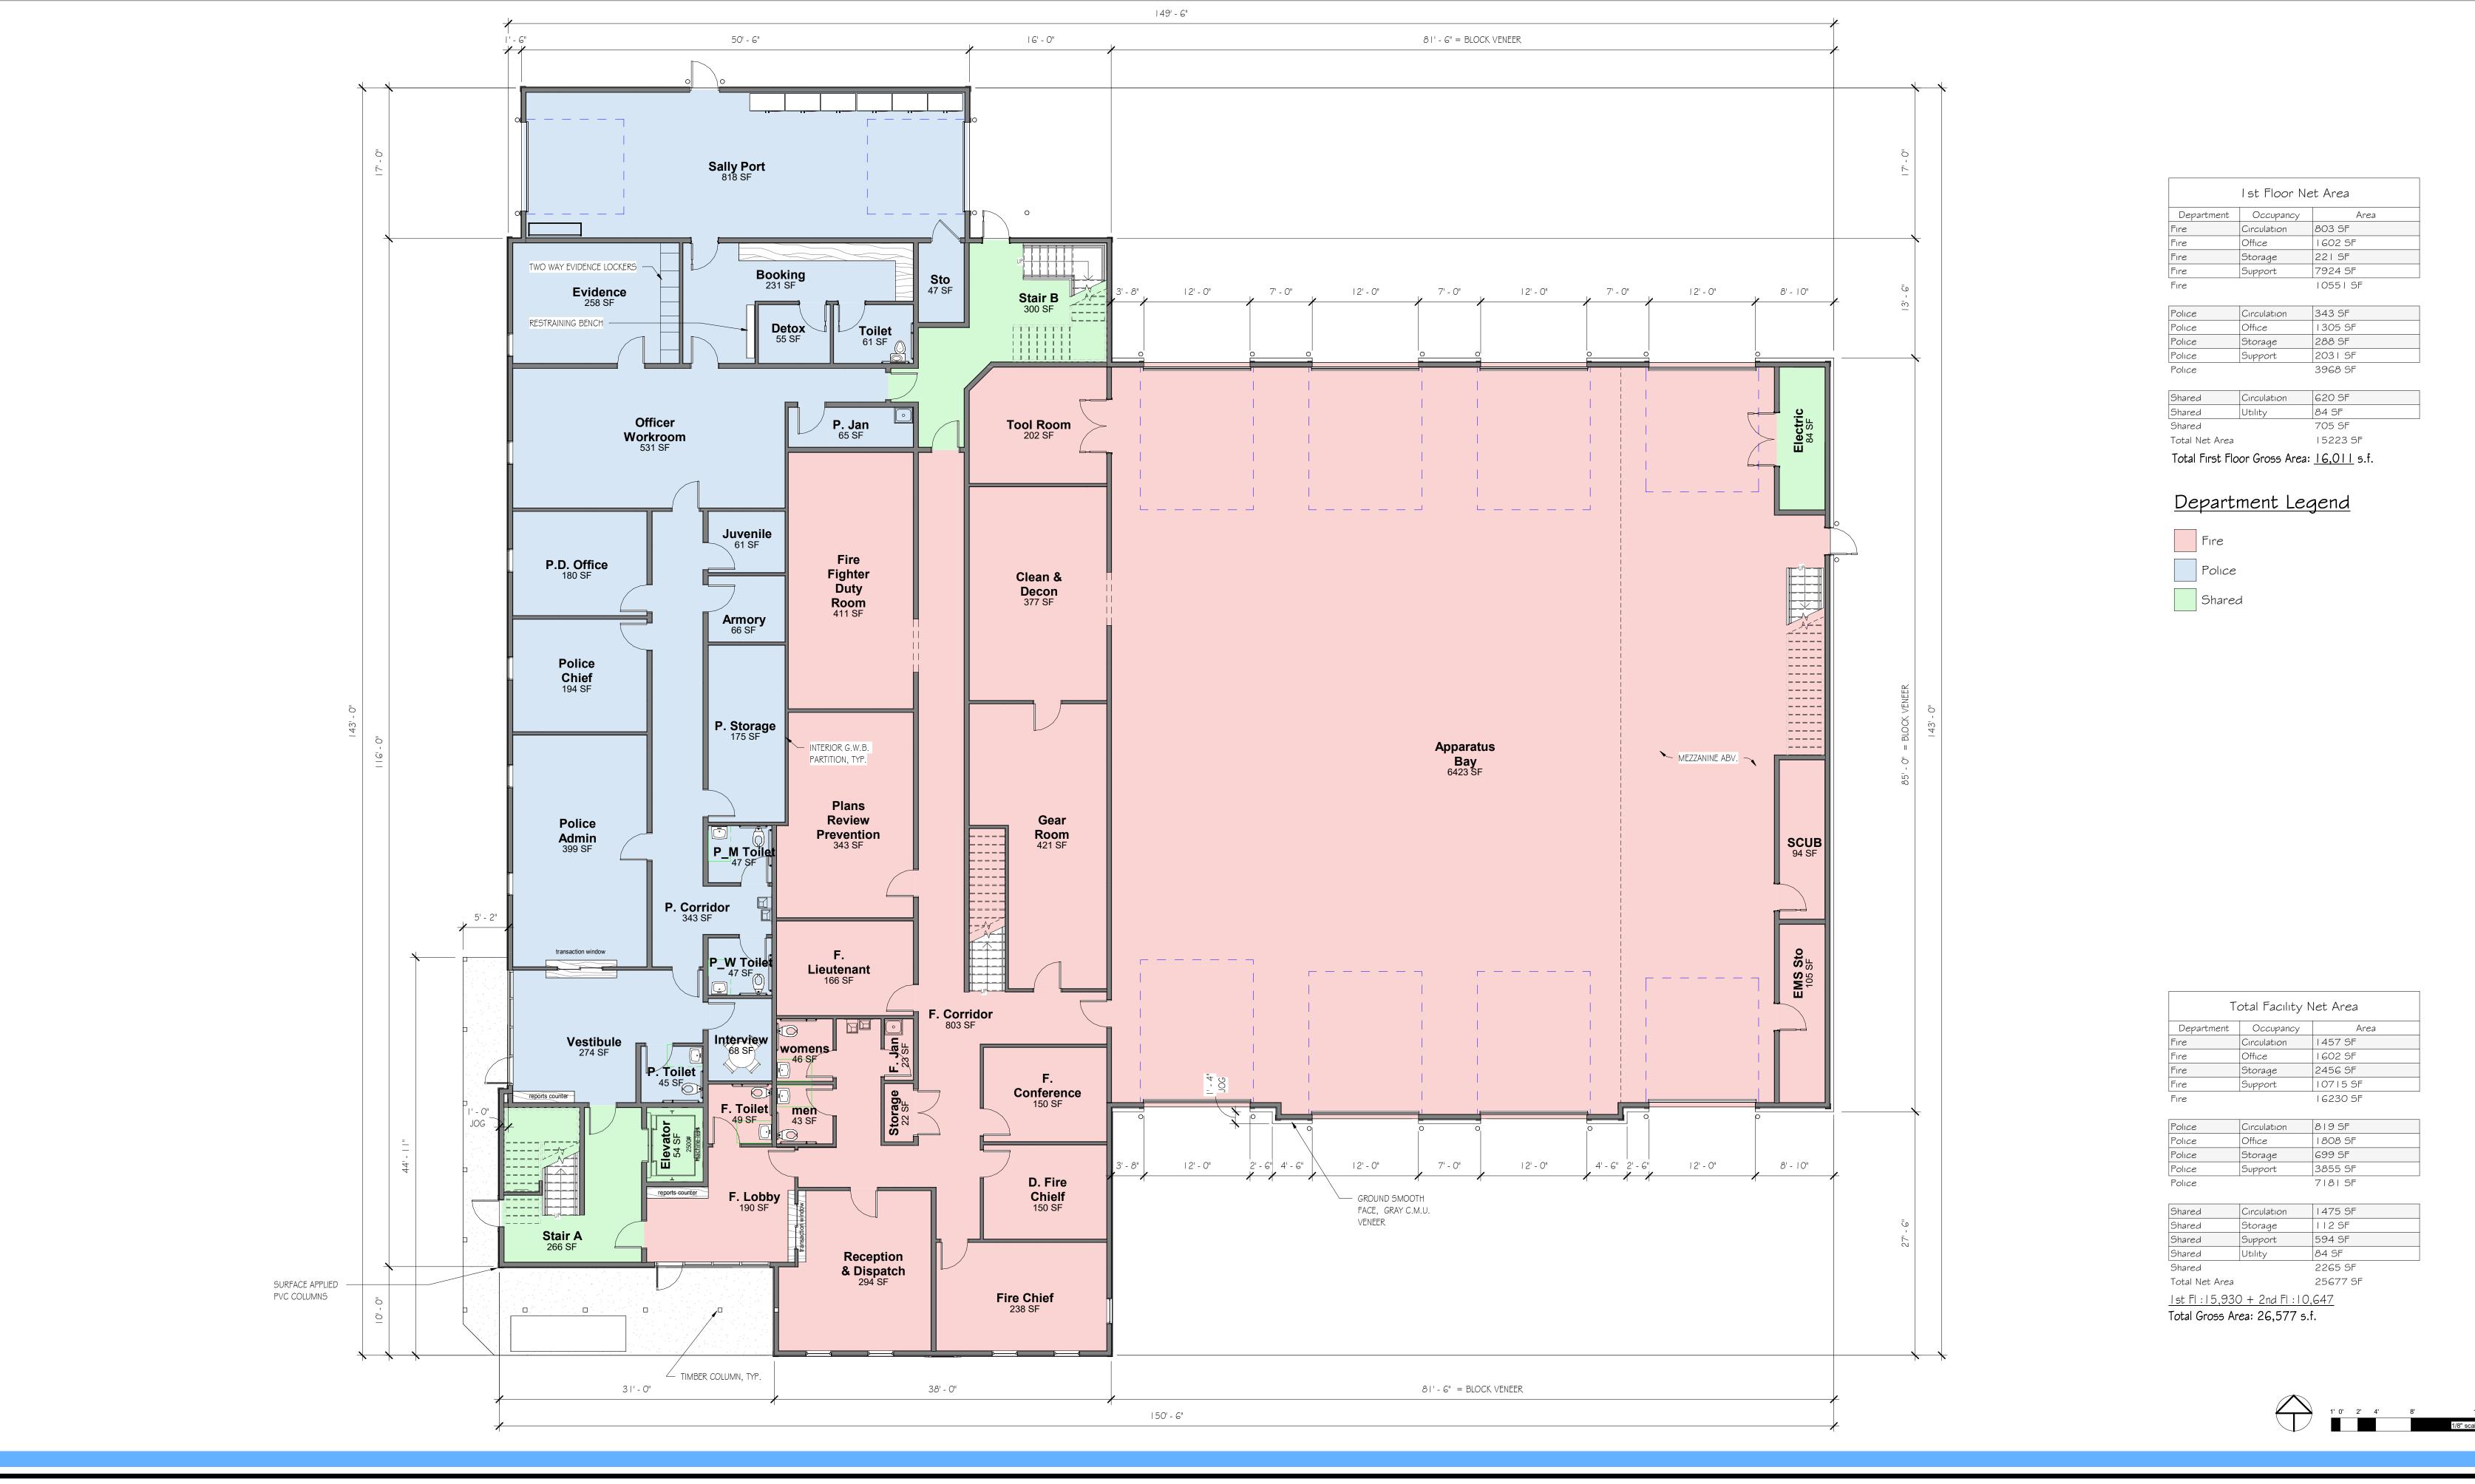







1/8" = 1'-0"

12/13/21

